2-4 VIMY ST, BANKSTOWN, NSW 2200 **CONCEPT STORMWATER PLAN**

GENERAL

G1. THESE DRAWINGS SHALL BE READ IN CONJUNCTION WITH ALL ARCHITECTURAL & OTHER WORKING DRAWINGS, SPECIFICATIONS & WITH SUCH WRITTEN INSTRUCTIONS AS MAY BE ISSUED DURING THE COURSE OF THE CONTRACT.

G2. ALL WORKMANSHIP & MATERIALS SHALL BE IN ACCORDANCE WITH THE REQUIREMENTS OF THE CURRENT EDITION OF THE RELEVANT AUSTRALIAN STANDARDS, THE BUILDING CODE OF AUSTRALIA AND ANY OTHER APPLICABLE AUTHORITY REQUIREMENTS.

G3. ANY CONFLICT BETWEEN THESE NOTES, THE SPECIFICATION, THE DRAWINGS OR ANY OTHER RELEVANT DOCUMENTS SHALL BE REFERRED TO ABCON ENGINEERS FOR DECISION PRIOR TO PROCEEDING WITH THE WORK.

G4. DIMENSIONS SHALL NOT BE OBTAINED BY SCALING THE DRAWINGS. FOR SETTING OUT DIMENSIONS & LEVELS REFER TO ARCHITECTURAL DRAWINGS.

G5. THE BUILDER SHALL BE RESPONSIBLE FOR THE PROVISION OF ALL SHORING TO MAINTAIN THE STABILITY & INTEGRITY OF EXCAVATIONS & ADJACENT STRUCTURES.

G6. IT IS THE CONTRACTOR'S RESPONSIBILITY TO LOCATE ALL SERVICES PRIOR TO COMMENCEMENT OF ANY EARTHWORKS.

G7. ALL DIMENSIONS ARE IN MILLIMETERS UNLESS NOTED OTHERWISE.

STORMWATER

W1. ALL LEVELS ARE TO A.H.D. UNO.

W2. THE STORMWATER SYSTEM IS DESIGNED TO COMPLY WITH COUNCIL'S DESIGN CRITERIA AND TO APPROXIMATELY MAINTAIN EXISTING FLOW PATTERNS.

W3. OVERLAND FLOW PATHS ARE PRESERVED.

W4. EXISTING DRAINAGE AND LEVELS ARE BASED ON SURVEY PROVIDED & SHOULD BE ASSUMED TO BE APPROXIMATE. ALLOW TO CONFIRM ALL RELEVANT DETAILS BEFORE PROCEEDING WITH AFFECTED AREAS.

W5. ALL WORK TO COMPLY WITH AS3500.3.

W6. ALL PITS TO BE PRECAST CONCRETE OR F.R.C. UNO.

W7. DOWNPIPE LOCATIONS SHOULD BE CONFIRMED WITH ARCHITECT'S PLAN UNO.

W8. GRADE LOCAL SURFACES INTO PITS TO ENSURE COLLECTION OF WATER & THAT THERE ARE NO AREAS OF PONDING, TYPICAL.

W9. GRATED TRENCHES AND SILT ARRESTOR PITS TO BE INSPECTED AND CLEANED AFTER PERIODS OF HEAVY RAINFALL.

W10. TREE ROOTS TO BE AVOIDED DURING PLACEMENT OF DRAINAGE SYSTEM.

W11. ALL PIPES TO BE Ø100 UPVC UNO.

W12. ALL PIPES TO HAVE 100 MIN. COVER IN LANDSCAPED AREAS AND 600 MIN. COVER IN TRAFFICABLE AREAS.

W13. ALL INLET AND OUTLET PIPES FROM PITS TO BE CONNECTED AT THE HIGHEST POSSIBLE INVERT LEVEL WHILST KEEPING 1% MIN. GRADE UNLESS NOTED OTHERWISE.

W14. FINISHED SURFACES TO BE GRADED AWAY FROM THE DWELLING AND TOWARD THE PITS.

W15. GRATED TRENCHES TO BE 1% MIN. GRADE THROUGHOUT TO OUTLET PIPE.

STORMWATER

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W14. FINISHED SURFACES TO BE GRADED AWAY FROM THE DWELLING AND TOWARD THE PITS.

W15. GRATED TRENCHES TO BE 1% MIN. GRADE THROUGHOUT TO OUTLET PIPE.


W1. ALL LEVELS ARE TO A.H.D. UNO.

W4. EXISTING DRAINAGE AND LEVELS ARE BASED ON SURVEY PROVIDED & SHOULD BE ASSUMED TO BE APPROXIMATE. ALLOW TO CONFIRM ALL RELEVANT DETAILS BEFORE PROCEEDING WITH AFFECTED AREAS.

W5. ALL WORK TO COMPLY WITH AS3500.3.





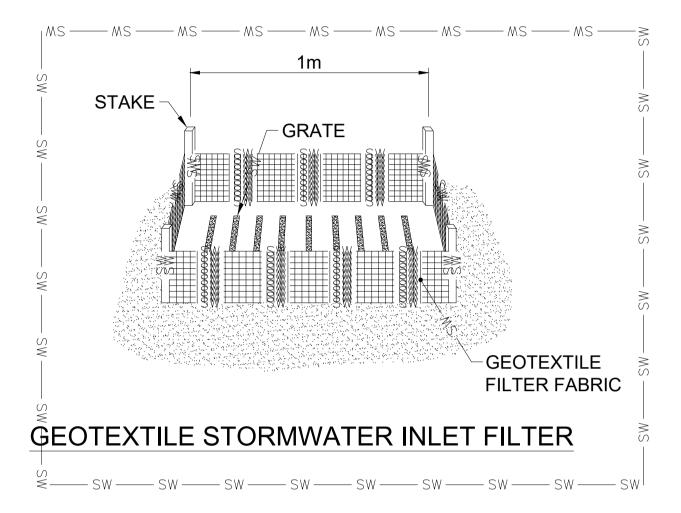

	21/06/2024	ISSUED FOR DA
	18/04/2024	STORMWATER CONCEPT PLAN
	04/12/2023	ISSUED FOR LANDSCAPE ARCHITECT
	01/12/2023	ISSUED FOR LANDSCAPE ARCHITECT
V	DATE	DESCRIPTION
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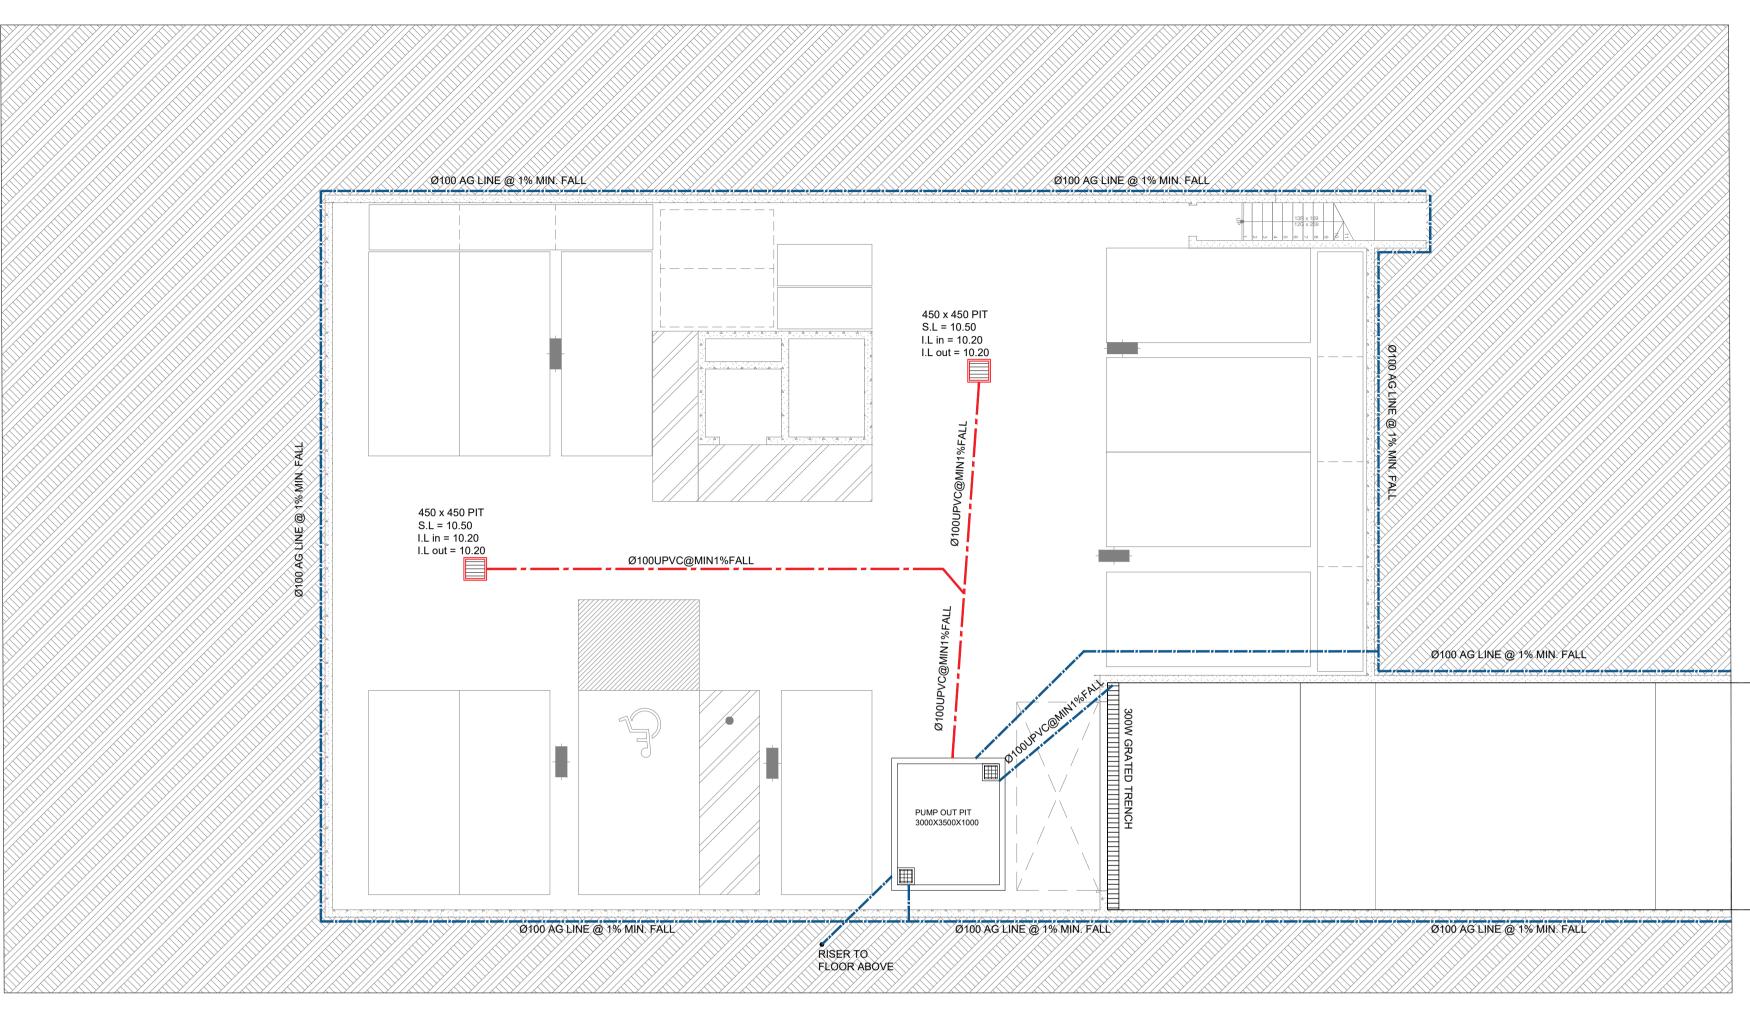
BY

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PROPOSED 2-4 VIN

D APARTMENT COMPLEX AT	JOB NUMBER: 23155	DWG NUMBER:	ORIGINAL SIZE:
MY ST, BANKSTOWN, NSW 2200	DESIGNED BY: MA	DATE: 21/06/2024	
STORMWATER NOTES	CHECKED BY: AK	SCALE: AS SHOWN	



D	21/06/2024	ISSUED FOR DA	МА
С	18/04/2024	STORMWATER CONCEPT PLAN	МА
В	04/12/2023	ISSUED FOR LANDSCAPE ARCHITECT	МА
А	01/12/2023	ISSUED FOR LANDSCAPE ARCHITECT	МА
REV	DATE	DESCRIPTION	BY

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PROPOSED 2-4 VIN

CONCE

ED APARTMENT COMPLEX AT 123165 12 1297 STORMWATER PLAN (BASEMENT) 1201 00 10 10 10 10 10 10 10 10 10 10 10 1				
ED APARTMENT COMPLEX AT 23155 C01 A1 VIMY ST, BANKSTOWN, NSW 2200 DESIGNED BY: DATE: A1 DEPT STORMWATER PLAN CHECKED BY: SCALE:				
ED APARTMENT COMPLEX AT 23155 C01 A1 VIMY ST, BANKSTOWN, NSW 2200 DESIGNED BY: DATE: A1 DEPT STORMWATER PLAN CHECKED BY: SCALE:				
ED APARTMENT COMPLEX AT 23155 C01 A1 VIMY ST, BANKSTOWN, NSW 2200 DESIGNED BY: DATE: A1 DEPT STORMWATER PLAN CHECKED BY: SCALE:				
ED APARTMENT COMPLEX AT 23155 C01 A1 VIMY ST, BANKSTOWN, NSW 2200 Designed by: Date: A1 DEPT STORMWATER PLAN CHECKED BY: SCALE:				
ED APARTMENT COMPLEX AT 23155 C01 A1 IMY ST, BANKSTOWN, NSW 2200 Designed by: Date: A1 DEPT STORMWATER PLAN CHECKED BY: SCALE:				
	YIMY ST, BANKSTOWN, NSW 2200	23155 DESIGNED BY: MA	C01 DATE: 21/06/2024	

WARNING PUMP OUT SYSTEM FAILURE IN BASEMENT WHEN LIGHT IS FLASHING AND SIREN SOUNDING

BASEMENT PUMP OUT FAILURE WARNING SIGN NOTE:

1- SIGN SHALL BE PLACED IN A CLEAR AND VISIBLE LOCATION WHERE VEHICLES ENTER THE BASEMENT.

COLOURS:

"WARNING" – RED BORDER AND OTHER LETTERING - BLACK

PUMP SPECIFICATIONS STANDARD PUMP-OUT NOTES

THE PUMP-OUT SYSTEM IS DESIGNED TO WORK IN THE FOLLOWING MANNER -

- 1. THE PUMPS SHALL BE PROGRAMMED TO WORK ALTERNATELY SO AS TO ALLOW BOTH PUMPS TO HAVE EQUAL OPERATION LOAD & PUMP LIFE.
- 2. A LOW LEVEL FLOAT SHALL BE PROVIDED TO ENSURE THAT THE MINIMUM REQUIRED WATER LEVEL IS MAINTAINED WITHIN THE SUMP AREA OF THE BELOW GROUND TANK. IN THIS REGARD THIS FLOAT WILL FUNCTION AS AN OFF SWITCH FOR THE PUMPS.
- 3. A SECOND FLOAT SHALL BE PROVIDED AT A HIGHER LEVEL, APPROXIMATELY 300mm ABOVE THE MINIMUM WATER LEVEL, WHEREBY ONE OF THE PUMPS WILL OPERATE & DRAIN THE TANK TO THE LEVEL OF THE LOW LEVEL FLOAT.
- 4. A THIRD FLOAT SHALL BE PROVIDED AT A HIGH LEVEL, WHICH IS APPROXIMATELY THE ROOF LEVEL OF THE BELOW GROUND TANK. THIS FLOAT SHOULD START THE OTHER PUMP THAT IS NOT OPERATING & ACTIVATE THE ALARM.
- 5. AN ALARM SYSTEM SHALL BE PROVIDED WITH A FLASHING STROBE LIGHT & A PUMP FAILURE WARNING SIGN WHICH ARE TO BE LOCATED AT THE DRIVEWAY ENTRANCE TO THE BASEMENT LEVEL. THE ALARM SYSTEM SHALL BE PROVIDED WITH A BATTERY BACK-UP IN CASE OF POWER FAILURE.


COMPONENTS

1. TWO(2) PUMPS KWIKFLO SUBMERSIBLE PUMPS (415v OR 240v)

- 2. ONE(1) PUMPS KWIK START CONTROL PANEL (CONTROL DESIGN TO
- ALTERNATE PUMPS ON START ON CONSECUTIVE START OPERATION)
- 3. TWO(2) GATE VALVES (BRONZE)
- 4. TWO(2) CHECK VALVES (SWING TYPE) (BRONZE)
- 5. TWO(2) SETS OF DISCHARGE HOSES WITH KAMLOK QUICK RELEASE COUPLINGS
- 6. ALL IN TANK PIT/PIPE AND PIPE FITTINGS, BRACKETS/SUPPORTS, HD GAL. CHAINS
- 7. FOUR(4) KWIK START KENRAHN MERCURY LEVEL FLOAT REGULATORS
- 8. INSTALLATION IN PROVIDED TANK/PIT
- OPTIONS

1. TANK PACKAGE/COVERS/MANHOLE, ALARM BELL, LOW LEVEL ALARM REGULATOR

MODEL	DIS. SIZE	MOTOR kw	POWER	Max Capacity	Max Head	Wt. kgs	CABLE m
KPSS 250	40mm BSP	0.25	240v	220 L/min	8 metres	17	5.2metre
KPSS 400	50mm BSP	0.40	240v	290 L/min	13 metres	19	5.2metre
KPSS 750	50mm BSP	0.75	240or415v	380 L/min	16 metres	20	5.2metre

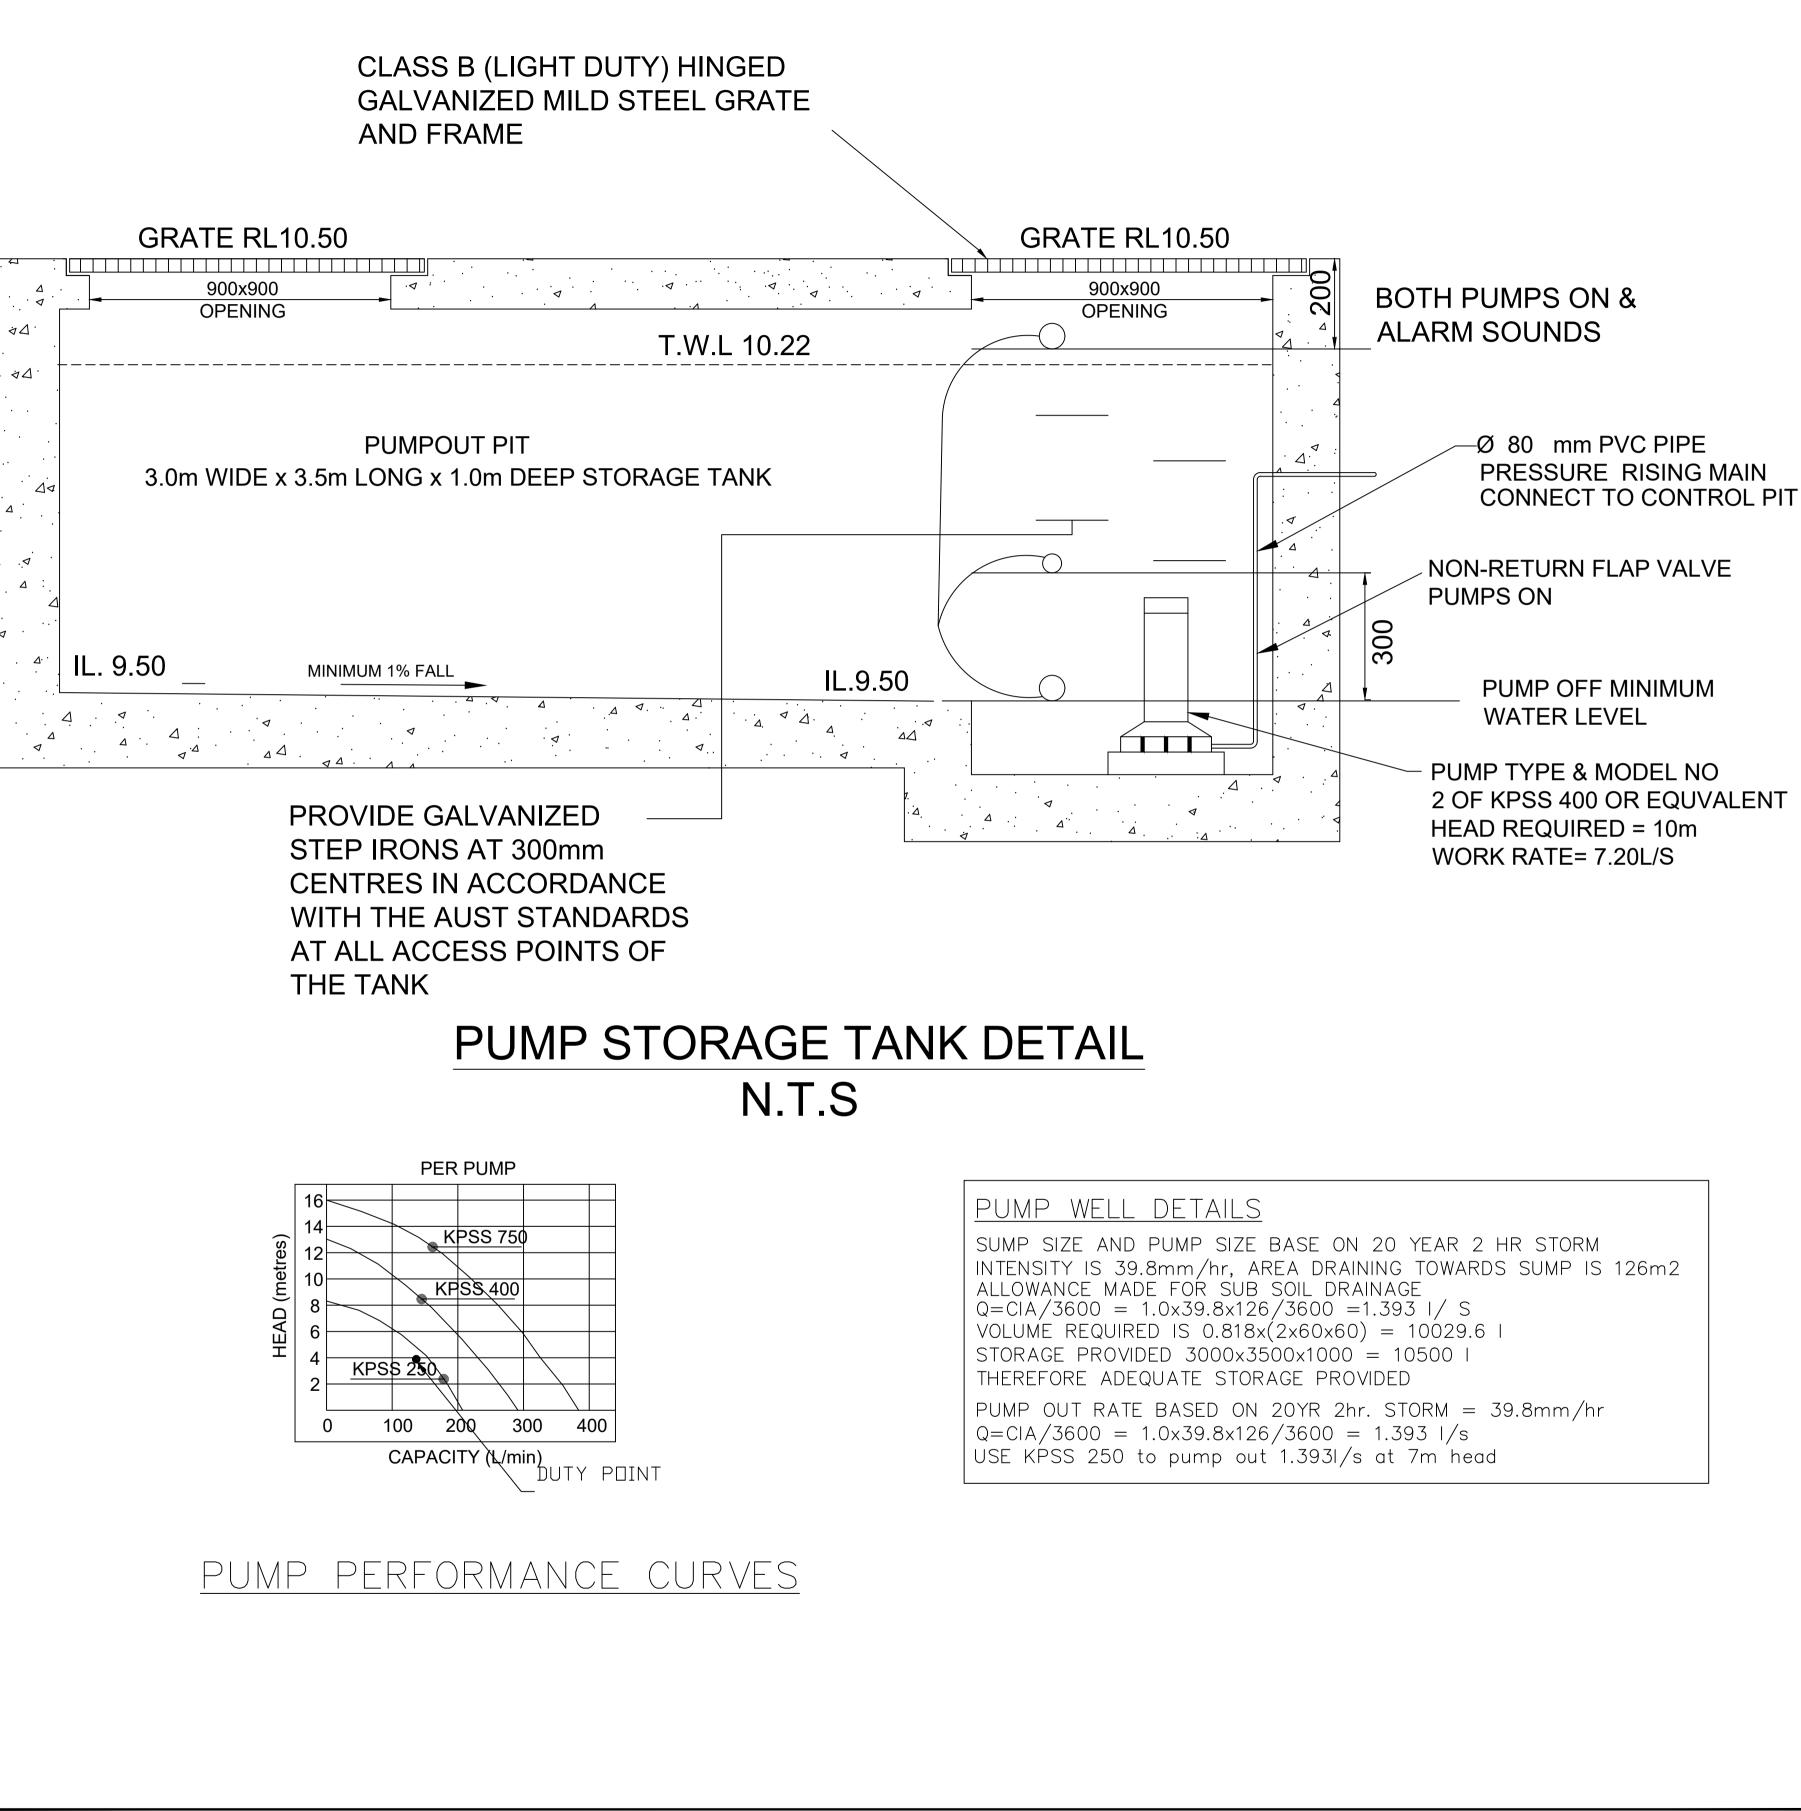

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18/04/2024	STORMWATER CONCEPT PLAN	MA
04/12/2023	ISSUED FOR LANDSCAPE ARCHITECT	MA
01/12/2023	ISSUED FOR LANDSCAPE ARCHITECT	MA
DATE	DESCRIPTION	BY
	18/04/2024 04/12/2023 01/12/2023	18/04/2024 STORMWATER CONCEPT PLAN 04/12/2023 ISSUED FOR LANDSCAPE ARCHITECT 01/12/2023 ISSUED FOR LANDSCAPE ARCHITECT

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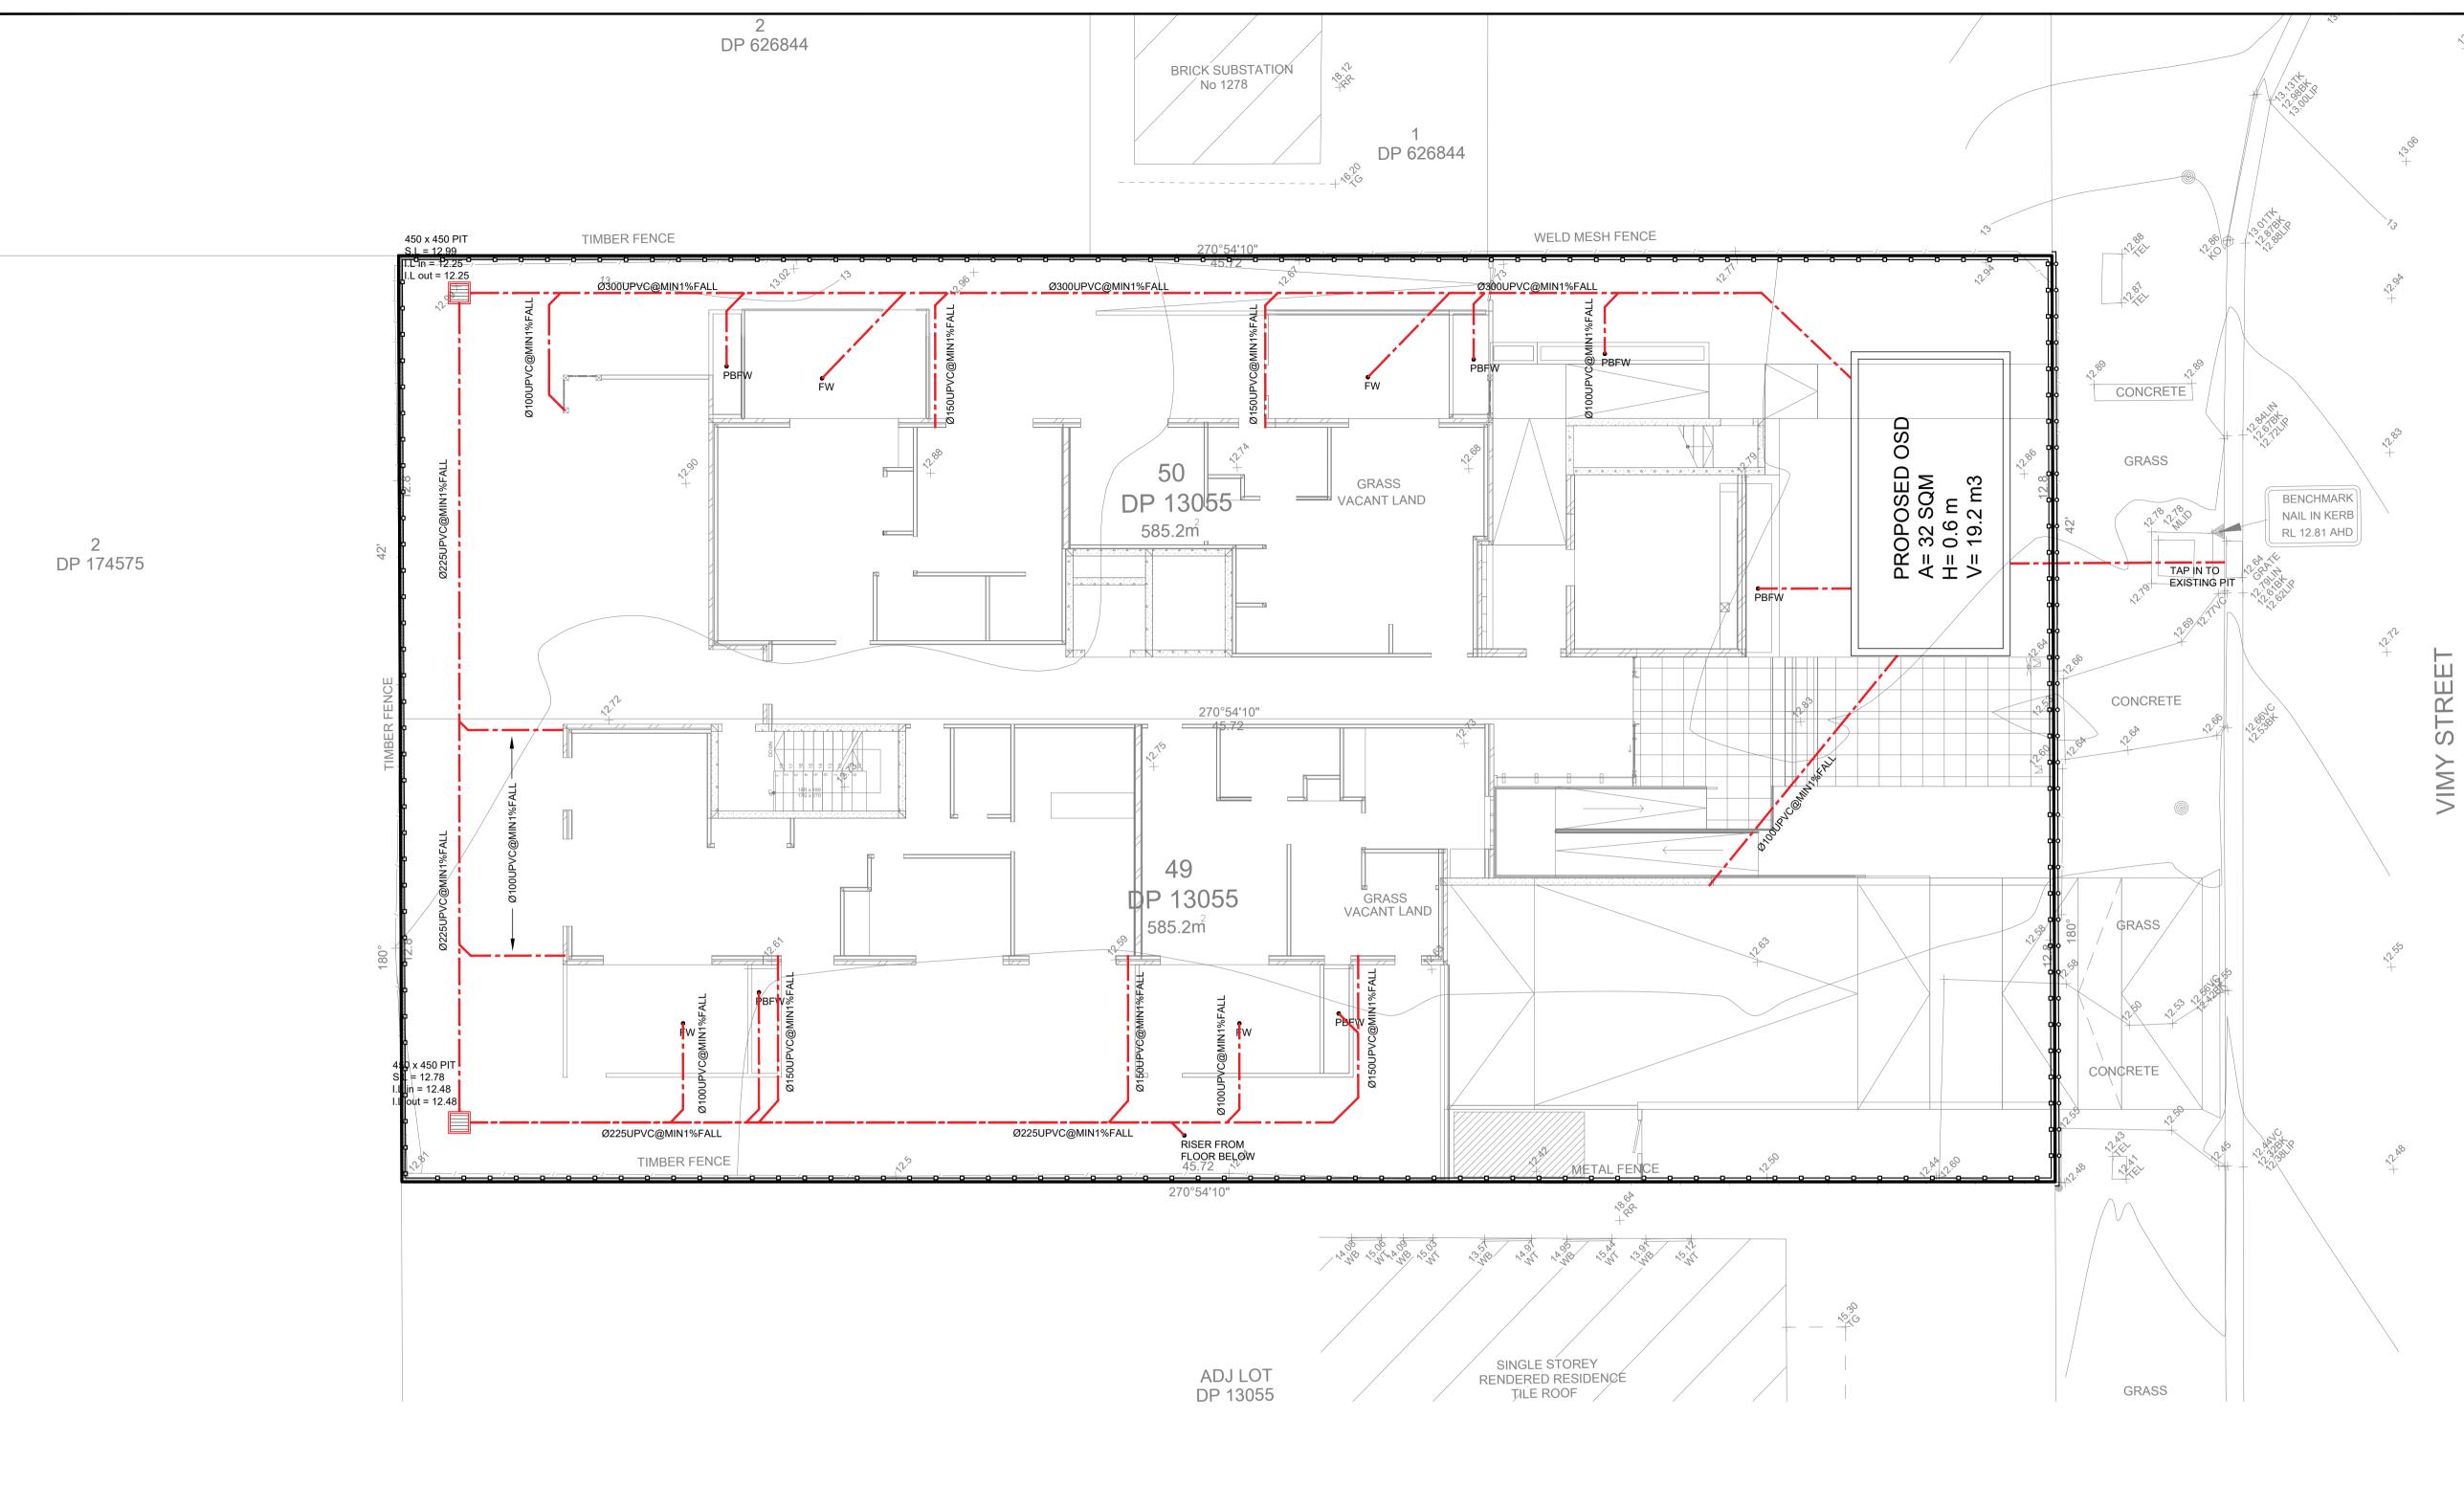
ABCON.

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ABCON

PROPOSED 2-4 VIM

D APARTMENT COMPLEX AT	JOB NUMBER: 23155	DWG NUMBER: C02	ORIGINAI A	
MY ST, BANKSTOWN, NSW 2200	DESIGNED BY: MA	DATE: 21/06/2024		
UMP OUT DETAILS	CHECKED BY: AK	SCALE: AS SHOWN		



NOTE: DOWNPIPE SIZE TO BE 100 DIA. DROPPER SIZE TO BE 150 DIA. GUTTER SIZE TO BE 150MM.

SEDIMENT CONTROL NOTES:

1- All EROSION AND SEDIMENT CONTROL MEASURES TO BE INSTALLED PRIOR TO SITE DISTURBANCE. 2- STRIPPING OF GRASS AND VEGETATION ETC. FROM SITE SHALL BE KEPT TO A MINIMUM. 3- ALL SEDIMENT CONTROL STRUCTURES TO BE INSPECTED AFTER EACH RAINFALL EVENT FOR AND ALL TRAPPED SEDIMENT TO STRUCTURAL DAMAGE BE REMOVED TA A NOMINATED STOCKPILE SITE.

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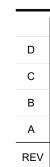
PROPOSED 2-4 VIM CONCE

_____**___**____

D APARTMENT COMPLEX AT	JOB NUMBER: 23155	dwg number: C03	ORIGINAL SI	ZE:
MY ST, BANKSTOWN, NSW 2200	DESIGNED BY: MA	DATE: 21/06/2024		
EPT STORMWATER PLAN (GROUND FLOOR)	CHECKED BY: AK	SCALE: AS SHOWN		

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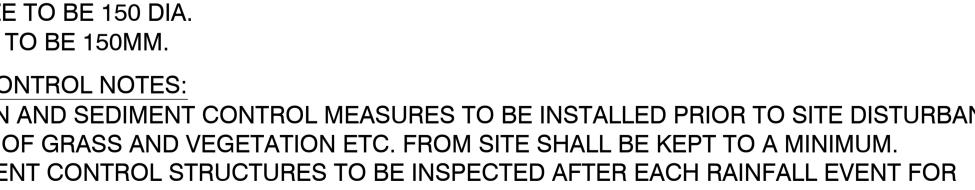
SITE BOUNDARY SEDIMENT CONTROL LINE TEMPORARY FENCE




NOTE: DOWNPIPE SIZE TO BE 100 DIA. DROPPER SIZE TO BE 150 DIA. GUTTER SIZE TO BE 150MM.

SEDIMENT CONTROL NOTES:

1- All EROSION AND SEDIMENT CONTROL MEASURES TO BE INSTALLED PRIOR TO SITE DISTURBANCE. 2- STRIPPING OF GRASS AND VEGETATION ETC. FROM SITE SHALL BE KEPT TO A MINIMUM. 3- ALL SEDIMENT CONTROL STRUCTURES TO BE INSPECTED AFTER EACH RAINFALL EVENT FOR AND ALL TRAPPED SEDIMENT TO STRUCTURAL DAMAGE BE REMOVED TA A NOMINATED STOCKPILE SITE.



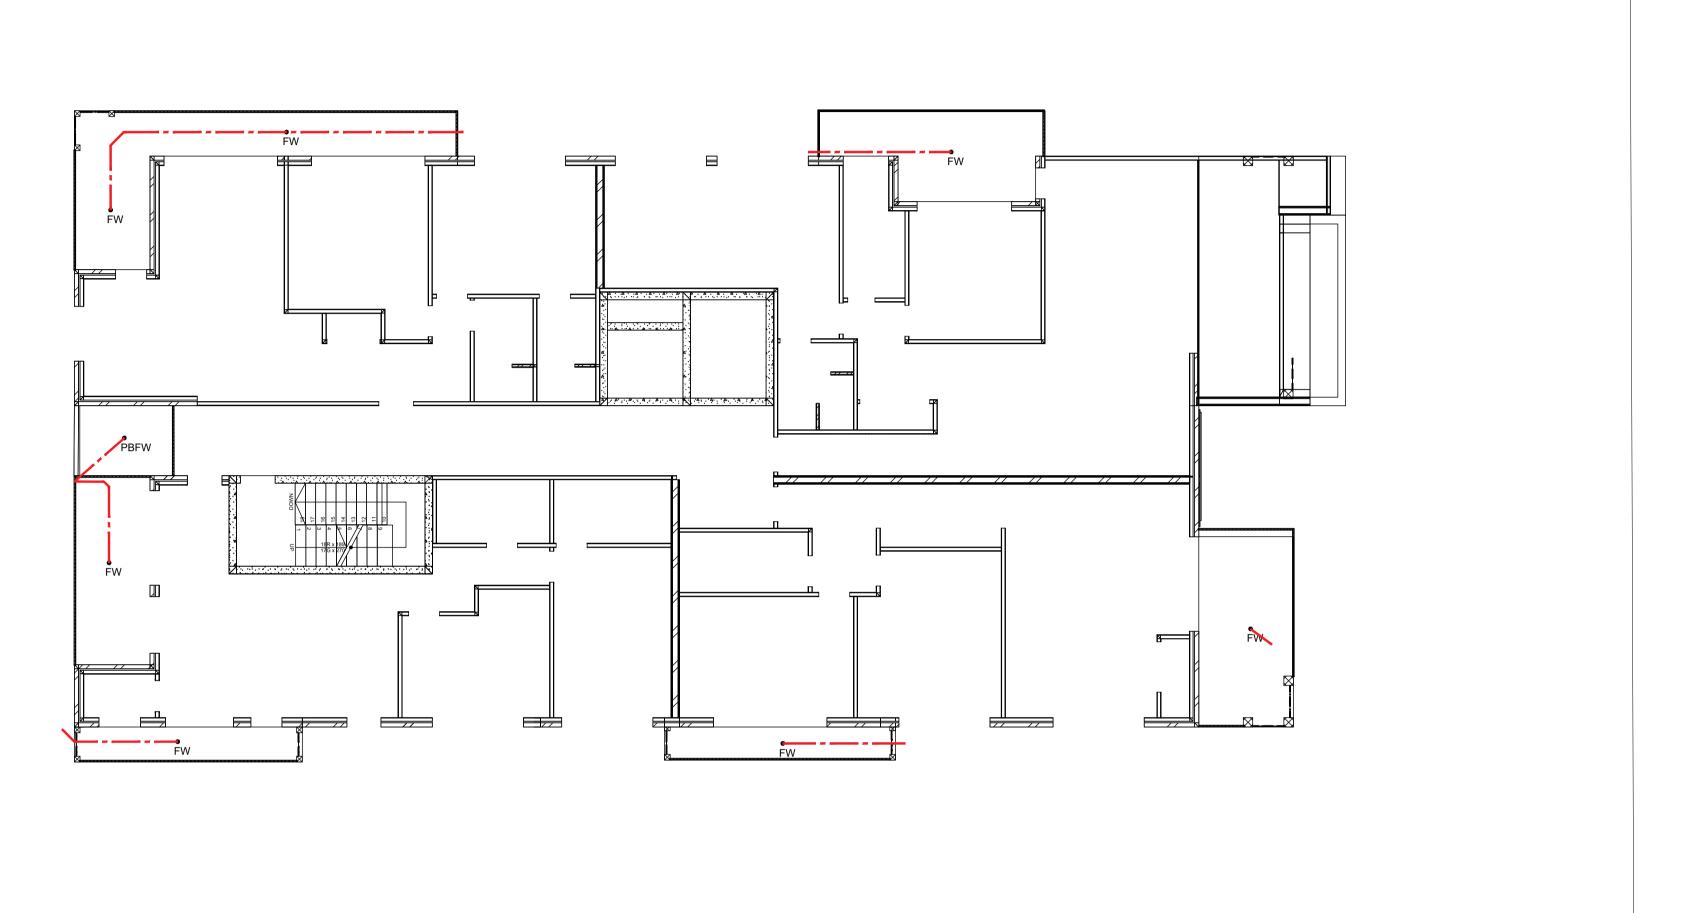

D 21/06/2024 ISSUED FOR DA MA C 18/04/2024 STORMWATER CONCEPT PLAN MA B 04/12/2023 ISSUED FOR LANDSCAPE ARCHITECT MA A 01/12/2023 ISSUED FOR LANDSCAPE ARCHITECT MA BY REV DATE DESCRIPTION

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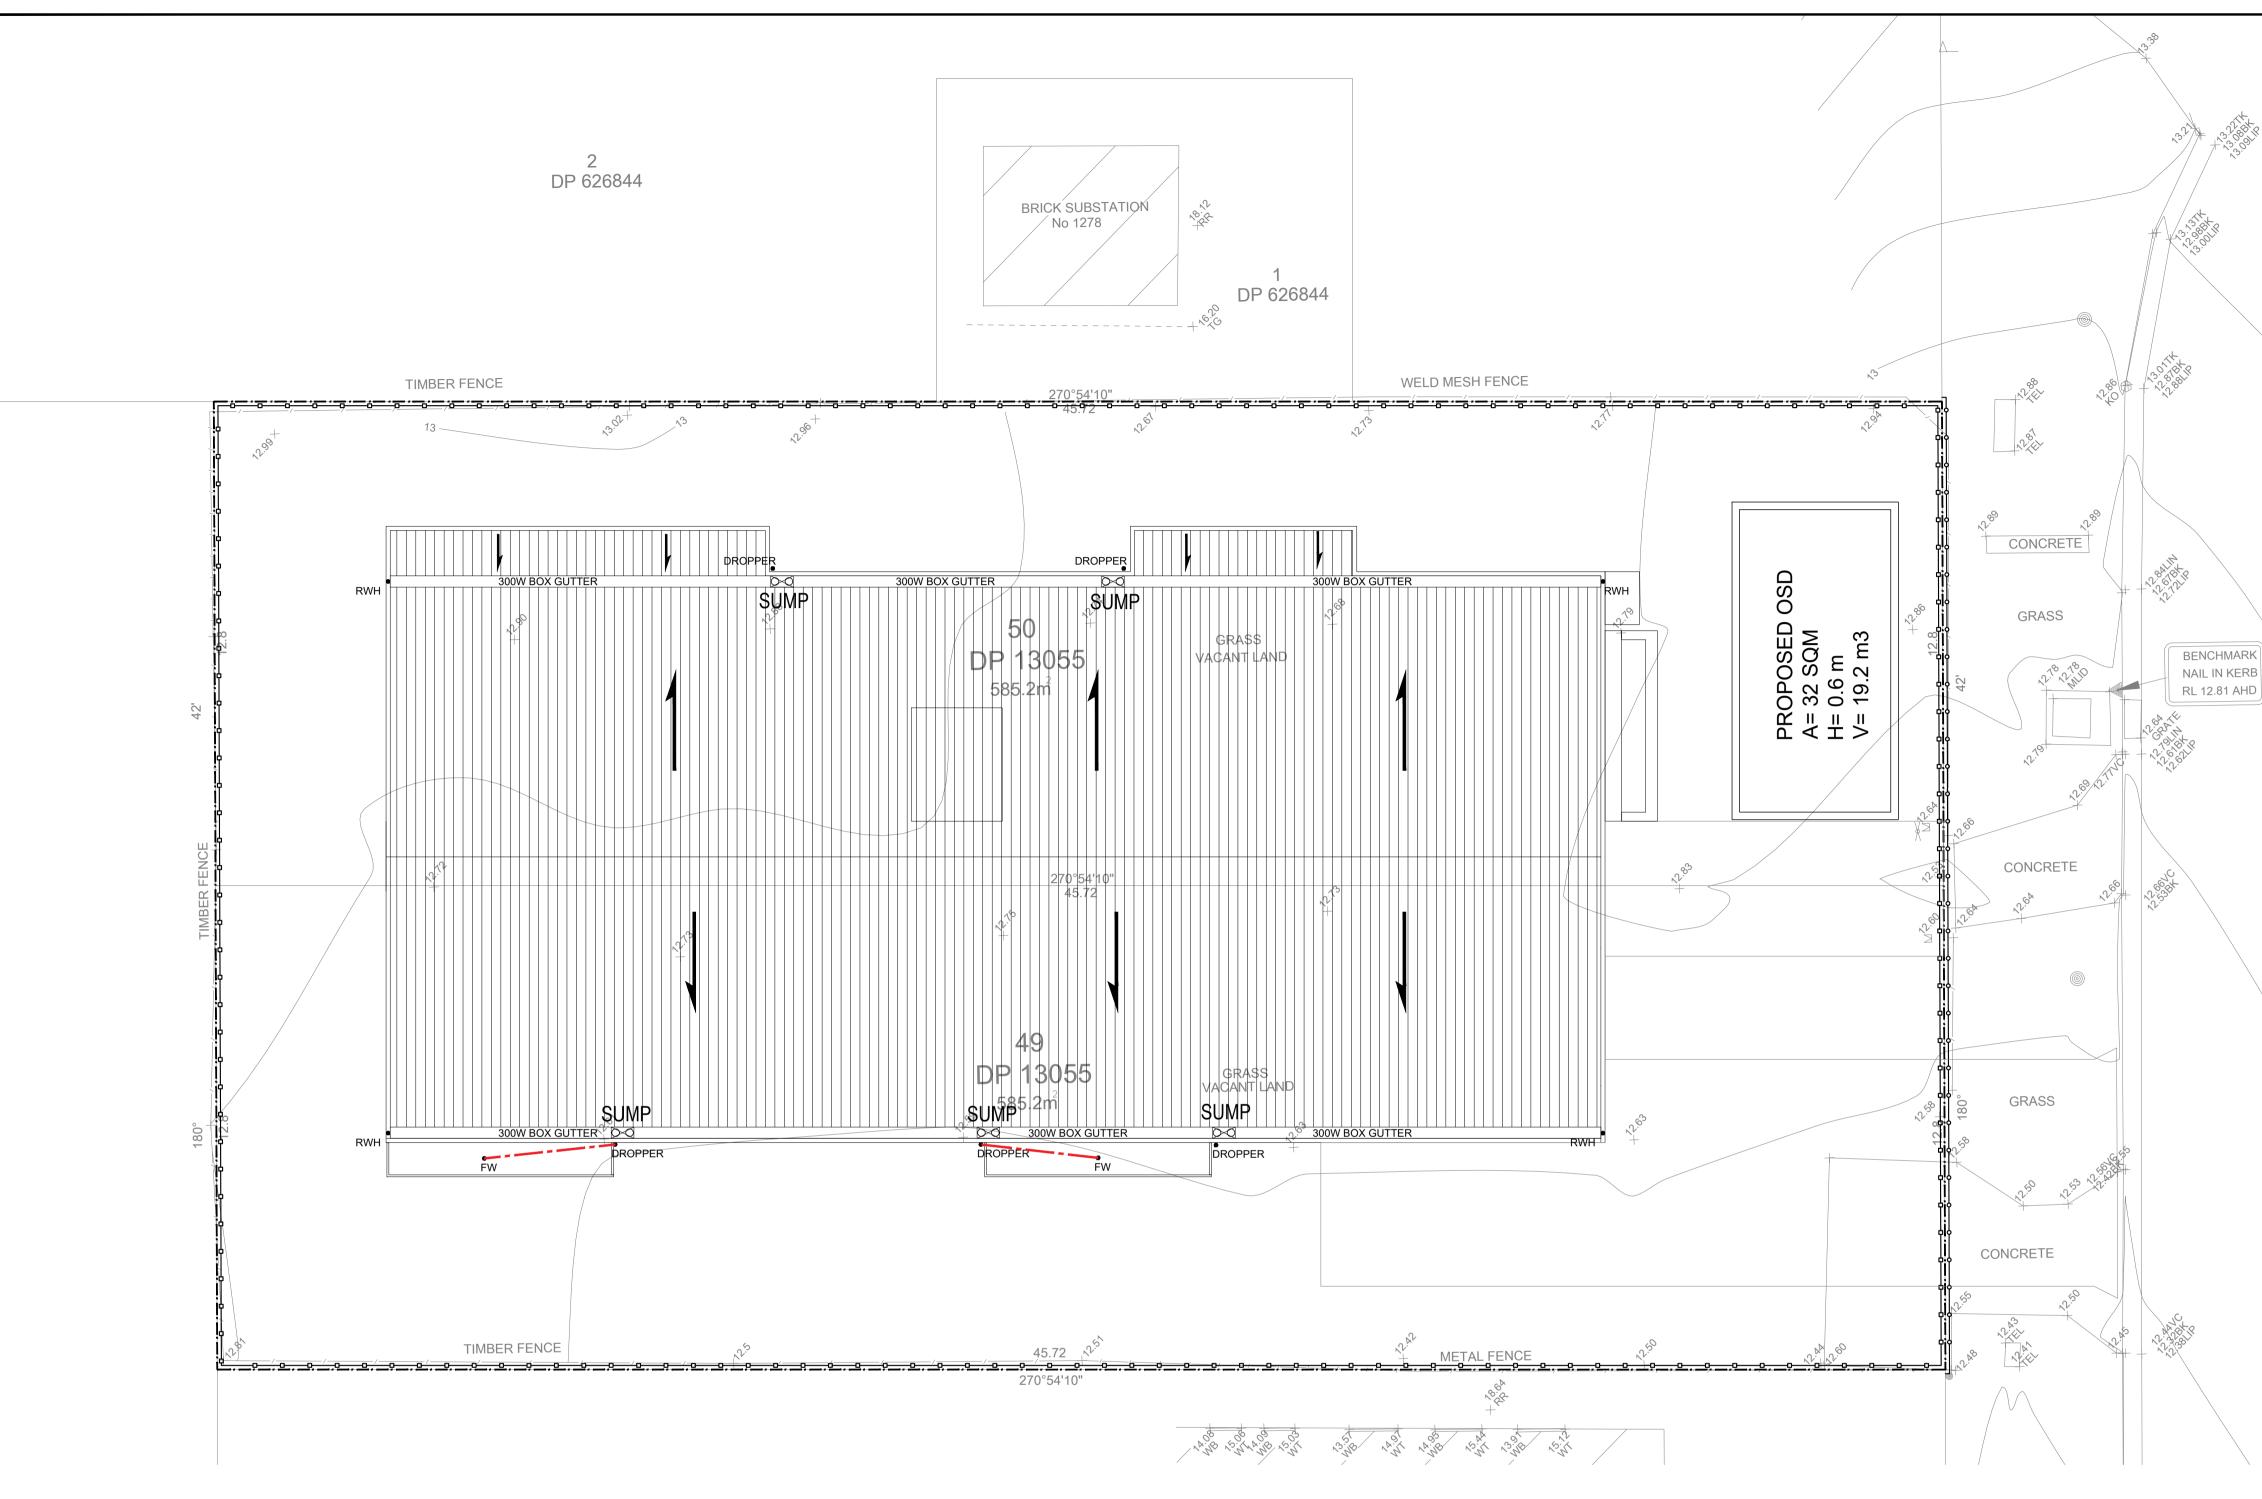


PROPOSED 2-4 VIMY CONCEF

D APARTMENT COMPLEX AT	JOB NUMBER: 23155	DWG NUMBER:	ORIGINAL	
MY ST, BANKSTOWN, NSW 2200	DESIGNED BY: MA	DATE: 21/06/2024		
EPT STORMWATER PLAN (FIRST FLOOR)	CHECKED BY: AK	SCALE: AS SHOWN		

<u>00000</u> 0000

SITE BOUNDARY SEDIMENT CONTROL LINE TEMPORARY FENCE



NOTE:

DOWNPIPE SIZE TO BE 100 DIA. DROPPER SIZE TO BE 150 DIA. GUTTER SIZE TO BE 150MM.

SEDIMENT CONTROL NOTES:

 All EROSION AND SEDIMENT CONTROL MEASURES TO BE INSTALLED PRIOR TO SITE DISTURBANCE.
 STRIPPING OF GRASS AND VEGETATION ETC. FROM SITE SHALL BE KEPT TO A MINIMUM.
 ALL SEDIMENT CONTROL STRUCTURES TO BE INSPECTED AFTER EACH RAINFALL EVENT FOR AND ALL TRAPPED SEDIMENT TO STRUCTURAL DAMAGE BE REMOVED TA A NOMINATED STOCKPILE SITE.

	21/06/2024	ISSUED FOR DA	M
	18/04/2024	STORMWATER CONCEPT PLAN	M
	04/12/2023	ISSUED FOR LANDSCAPE ARCHITECT	M
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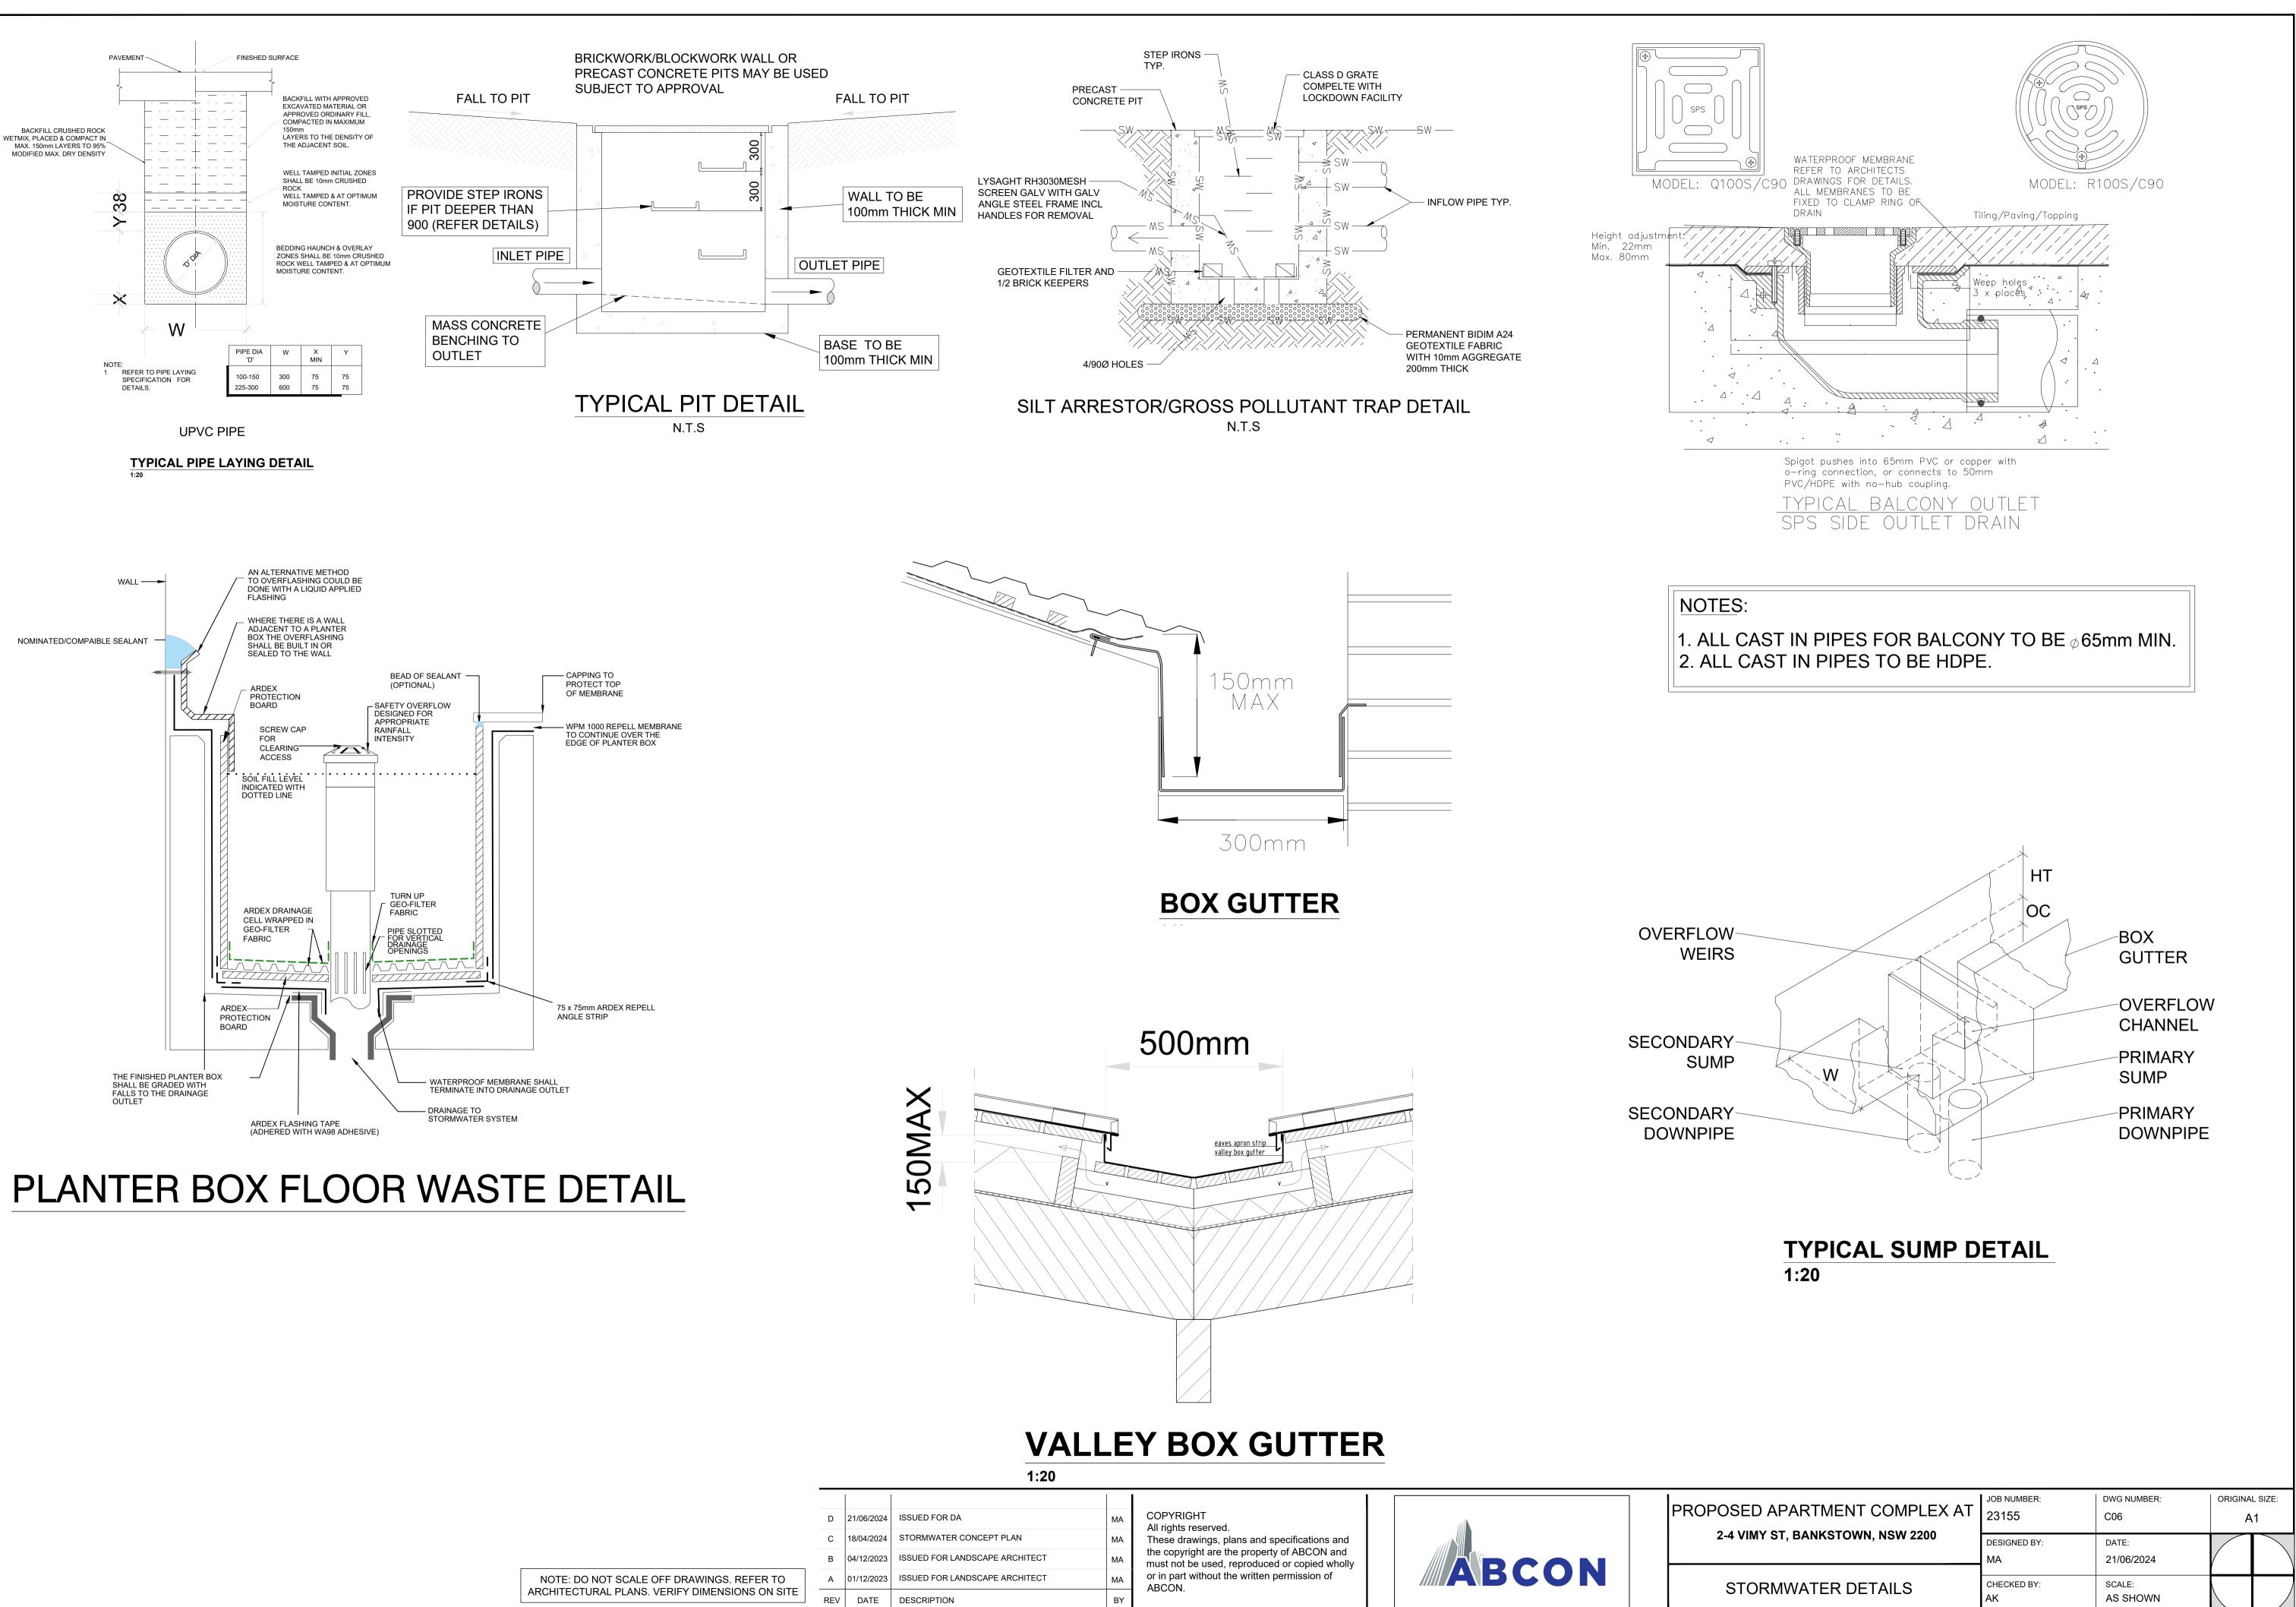
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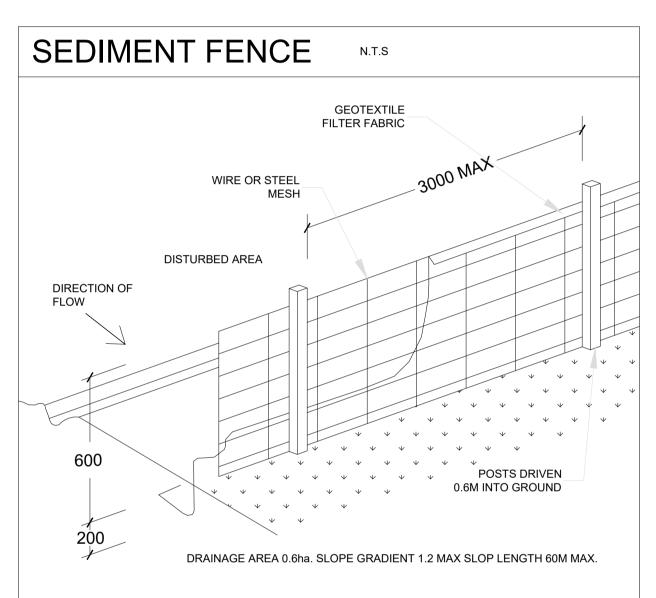
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23 23 24 +			
NRK ERB HD			
VIMY STREET			
24- +			
N- N- N-			
	JOB NUMBER:	DWG NUMBER:	ORIGINAL SIZE:
ED APARTMENT COMPLEX AT	23155 DESIGNED BY:	C05 DATE:	A1
CEPT STORMWATER PLAN	МА	21/06/2024	
(ROOF)	CHECKED BY: AK	SCALE: AS SHOWN	



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	18/04/2024	STORMWATER CONCEPT PLAN	MA
	04/12/2023	ISSUED FOR LANDSCAPE ARCHITECT	MA
	01/12/2023	ISSUED FOR LANDSCAPE ARCHITECT	MA
/	DATE	DESCRIPTION	BY






### CONSTRUCTION NOTES

1) CONSTRUCT SEDIMENT FENCE AS CLOSE AS POSSIBLE TO THE CONTOURS OF THE SITE. 2) DRIVE 1.5 METERS LONG STAR PICKETS INTO GROUND, 3 METERS APART. 3) DIG A 150MM DEEP TRENCH ALONG THE UPSLOPE LINE OF THE FENCE FOR THE BOTTOM OF THE FABRIC TO BE ENTRENCHED.

4)BACKFILL TRENCH OVER BASE OF FABRIC.

5)FIX SELF-SUPPORTING GEOTEXTILE TO UPSLOPE SIDE OF POSTS WITH WIRE TIES OR AS RECOMMENDED BY GEOTEXTILE MANUFACTURE. 6) JOIN SECTION OF FABRIC AT A SUPPORT POST WITH A 150MM OVERLAP.

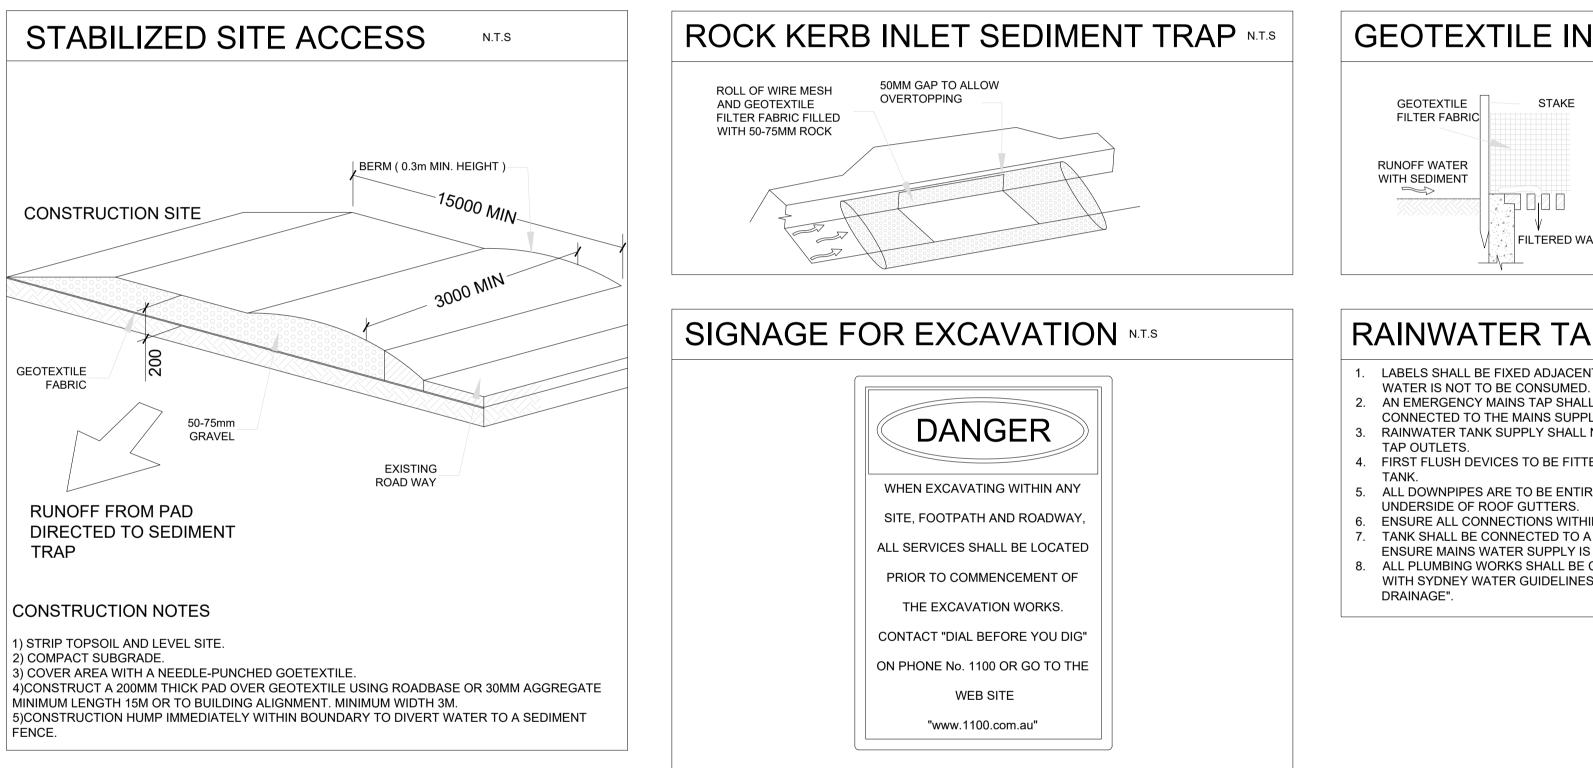

# SEDIMENT & EROSION CONTROL PLAN

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С	18/04/2024	STORMWATER CONCEPT PLAN	МА
В	04/12/2023	ISSUED FOR LANDSCAPE ARCHITECT	МА
А	01/12/2023	ISSUED FOR LANDSCAPE ARCHITECT	МА
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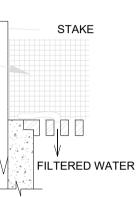
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PROPOSED 2-4 VIM)

SEDIME

# GEOTEXTILE INLET SEDIMENT TRAP N.T.S



CONSTRUCTION NOTES

1) FABRICATE A SEDIMENT BARRIER FROM

GEOTEXTILE. 2) SUPPORT GEOTILE WITH MESH TIED TO POSTS AT 1M CENTERS. 3)DO NOT COVER INLET WITH GOETEXTILE.

# **RAINWATER TANK**

LABELS SHALL BE FIXED ADJACENT TO ALL OUTDOOR WATERING TAPS STATING THAT THE 2. AN EMERGENCY MAINS TAP SHALL BE PROVIDED ADJACENT TO THE WATER METER AND CONNECTED TO THE MAINS SUPPLY 3. RAINWATER TANK SUPPLY SHALL NOT BE CONNECTED TO DRINKING AND BATHING WATER

4. FIRST FLUSH DEVICES TO BE FITTED TO ALL DOWNPIPES CONNECTED TO THE RAINWATER

ALL DOWNPIPES ARE TO BE ENTIRELY P.V.C ALL PIPES ARE TO BE SEALED UP TO THE

6. ENSURE ALL CONNECTIONS WITHIN CHARGED SYSTEMS ARE SOLVENT WELDED. 7. TANK SHALL BE CONNECTED TO A SYDNEY WATER APPROVED CONTROL PANEL TO ENSURE MAINS WATER SUPPLY IS PROVIDE WHEN TANK EMPTIES. 8. ALL PLUMBING WORKS SHALL BE CARRIED OUT BY A LICENSED PLUMBER IN ACCORDANCE WITH SYDNEY WATER GUIDELINES AND THE "NSW CODE OF PRACTICE: " PLUMBING AND

D APARTMENT COMPLEX AT MY ST, BANKSTOWN, NSW 2200	JOB NUMBER: 23155	DWG NUMBER: C07	ORIGINAL SIZE:	
	DESIGNED BY: MA	DATE: 21/06/2024		
ENT CONTROL DETAILS	CHECKED BY: AK	SCALE: AS SHOWN		